

1080 Farnsworth Rd. Waterville, OH 43566 419450.0636 tel ajchristy007@hotmail.com



Designing Planning Remodeling

PROJECT TITLE:

New Residence for Steve & Lisa Potter

GENERAL CONTRACTOR:

REVISION:

FOR PRICING AND PERTIMS

DESIGNER: AJC

APPROVED:

AD JOB NO. 0202-15

SHEET NO.

A2.0

GENERAL NOTES

THESE PLANS WERE DRAFTED AND DESIGNED BY AARON J. CHRISTY TO SATISFY MOST LOCAL BUILDING CODES IN THE NORTHWEST OHIO & LOWER MICHIGAN AREAS AT THE TIME THEY WERE DRAWN. IT IS THE INTENT OF THESE DOCUMENTS TO PROVIDE SUFFICIENT INFORMATION TO THE EXPERIENCED BUILDER TO CONSTRUCT THE PROJECT SHOWN. HOWEVER, BECAUSE OF BUILDING CODES CAN CHANGE AND/OR CODE INTERPRETATION CAN VARY FROM JURISDICTION TO JURISDICTION, AARON J CHRISTY DOSE NOT GUARANTEE THE STRUCTURAL INTEGRITY OR BUILDING CODE COMPLIANCE OF ANY OF THE PARTICULARS OF THESE PLANS. IT IS, THEREFORE, STRONGLY RECOMMENDED THAT BEFORE ANY CONSTRUCTION COMMENCES OR CONTRACTUAL COMMITMENTS ARE MADE THAT THESE PLANS BE REVIEWED BY A STRUCTURAL ENGINEER FOR STRUCTURAL INTEGRITY, AS WELL AS FOR BUILDING CODE COMPLIANCE WITH ANY AND ALL APPLICABLE CODES, REGULATIONS AND ORDINANCES.

2. IT IS THE RESPONSIBILITY OF THE CONTRACTOR TO ABIDE BY ALL LAWS, CODES, ORDINANCES, ZONING AND ANY AND ALL GOVERNING REGULATIONS WITH RESPECT TO THIS PROJECT WHETHER SHOWN HERE IN OR NOT.

3. IF THESE PLANS ARE FOR AN ADDITION AND/OR RENOVATION TO AN EXISTING STRUCTURE, IT IS THE RESPONSIBILITY OF THE CONTRACTOR(S) TO VERIFY ALL EXISTING CONDITIONS, DIMENSIONS, ETC. AT THE JOB SITE PRIOR TO THE START OF CONSTRUCTION. IT IS ALSO THE RESPONSIBILITY OF THE CONTRACTOR(S) TO MODIFY ALL EXISTING CONSTRUCTION AS MAY BE REQUIRED TO ADAPT TO ANY NEW CONSTRUCTION.

4. THE PURCHASER OF THESE PLANS RELEASES AARON J. CHRISTY, FROM ANY CLAIMS OR LAWSUITS THAT MAY ARISE BEFORE OR DURING THE CONSTRUCTION OF THE STRUCTURE(S) DEPICTED IN THESE PLANS OR ANY TIME THEREAFTER.

5. ALL DIMENSIONS SHOULD BE READ OR CALCULATED AND NEVER SCALED.

6. ALL EXTERIOR WALLS ARE DIMENSIONED TO OUTSIDE OF 1/2" RIGID INSULATION. ALL INTERIOR WALLS ARE DIMENSIONED

7. THE CONTRACTOR(S) SHALL CHECK AND VERIFY DIMENSIONS, ETC. AT SITE BEFORE CONSTRUCTION AND/OR ORDERING MATERIAL. NOTIFY DESIGNER OF ANY DISCREPANCIES FOR CLARIFICATION BEFORE PROCEEDING WITH WORK

8. CONTRACTOR(S) SHALL INSURE COMPATIBILITY OF BUILDING WITH ALL SITE REQUIREMENTS AND VERIFY ALL UTILITY, STORM LINES ETC. FOR INTERFERENCE WITH EXCAVATION.

9. ALL MATERIALS, SUPPLIES AND EQUIPMENT TO BE INSTALLED AS PER MANUFACTURER'S SPECIFICATIONS AND PER LOCAL

CODES AND REQUIREMENTS. 10. ALL SECOND STORY WALLS ARE 8'-0" HIGH UNLESS OTHERWISE NOTED OR IMPLIED.

11. CONFIRM WINDOW OPENINGS FOR LOCAL EGRESS REQUIREMENTS AND MINIMUM LIGHT & VENTILATION REQUIREMENTS.

12. IF NO PARTICULAR WINDOW MANUFACTURER'S CATALOG NUMBERS HAVE BEEN NOTED(IE: ""GENERAL SIZE WINDOWS"), THEN WINDOW SIZES SHOWN ARE NORMINAL. IN THE CASE, EXACT SIZES SHALL BE DETERMINED BY CHOSEN MANUFACTURER'S CATALOG.

13. ALL ANGLED WALLS ON FLOOR PLANS ARE AT A 45 DEGREE ANGLE UNLESS OTHERWISE NOTED.

14. INSTALL EXHAUST FANS IN ALL BATHROOMS AND WATER CLOSET COMPARTMENTS AND OTHER SIMILAR ROOM PER 2013 RESIDENTIAL CODE OF OHIO; BUILDING CODE- SECTION R303.3 OR APPLICABLE LOCAL BUILDING CODE.

15. PROVIDE SAFETY GLAZING AT HAZARDOUS LOCATIONS PER 2013 RESIDENTIAL CODE OF OHIO; .-SECTION R308 OR APPLICABLE LOCAL BUILDING CODE.

16. INSTALL GUARDRAILS AND STAIR HANDRAIL PER 2013 RESIDENTIAL CODE OF OHIO; -SECTIONS R312 AND R311.7.7.1 OR APPLICABLE LOCAL BUILDING CODE.

17. INSTALL SMOKE ALARMS PER 2013 RESIDENTIAL CODE OF OHIO -SECTION R314.2 AND R314.3 OR APPLICABLE LOCAL BUILDING CODE.

18. INSTALL CARBON MONOXIDE ALARMS PER 2013 RESIDENTIAL CODE OF OHIO -SECTION R315 OR APPLICABLE LOCAL BUILDING CODE.

18. COMPLETELY SEPARATE GARAGE BENEATH FROM LIVING SPACE (HABITABLE) WITH MINIMUM 5/8" TYPE-X GYP. BOARD AND ATTIC AREA (UNINHABITABLE) SPACE WITH MINIMUM 1/2" GYP. BOARD - SECTION R302.6 PER 2013 RESIDENTIAL CODE OF OHIO

19. INSTALL 1/2" GYP. BD. ON ALL INTERIOR WALLS & CEILINGS. INSTALL 5/8" GYP. BD. AT ALL CEILINGS WHICH HAVE FRAMING AT AT 24" ON CENTER.

20. PENETRATIONS SHALL BE PROTECTED BY AN APPROVED PENETRATION FIRESTOP SYSTEM - SECTION R302.4.1.2 ANDR302 PER 2013 RESIDENTIAL CODE OF OHIO

21. PROVIDE ATTIC ACCESS WITH MINIMUM OF 22"x30" FRAMED OPENING. -SECTION R807 PER 2013 RESIDENTIAL CODE OF OHIO

22. PREFABRICATED FIREPLACE & FLUES ARE TO BE U.L.127 APPROVED AND INSTALLED PER MANUFACTURER'S SPECIFICATIONS. - SECTION R1004 PER 2013 RESIDENTIAL CODE OF OHIO

23. BRICK SILL TO HAVE FLASHING UNDER SILL AND UP UNDER SIDING. BRICK VENEER TO BE TIED TO STUD WALL WITH GALVANIZED BRICK TIES AND SHALL BE SPACED NOT MORE THAN 24" O.C. HORIZ. AND VERT. - SECTION R703.7

AND WEEPHOLES INSTALLED AT 33 O.C. -SECTION R703.7.6 PROVIDE BRICK LEDGE IN FOUNDATION

WAINSCOT STONE DETAIL

24. BUILD UP ROOF SADDLES TO CREATE POSITIVE ROOF DRAINAGE.

25. PROVIDE 1 SQUARE FOOT OF FREE VENTILATING AREA FROM GRAVITY ROOF VENT FOR EVERY 150 SQUARE FEET OF ROOF. - SECTION R806.2 PER 2013 RESIDENTIAL CODE OF OHIO

> - LAP WRB OVER SCREED WEEP SCREED

6" MIN. ABOVE WATER TABLE

- BEDDING SEAL UNDER GSM

STUDS FOR FASTENERS SUPPORT ANGLE WITH CONSTRUCTION ADHESIVE

MORTAR SETTING BED

- MORTAR JOINT (WHERE USED)

- CULTURED STONE

MORTAR SCRATCH COAT

MORTAR JOINT (WHERE USED)

- FOUNDATION WEEP SCREED

- BOTTOM OF APPLIED STONE AT CEMENT PLASTER SCREED

> SLOPE GRADE 2% MIN.

— LAP WRB OVER SCREED

- LATH FASTENER

26. ADJUST OVERHANGS TO MAINTAIN CONSISTENT LEVEL WHEN PLANS CALL FOR TWO DIFFERENT PITCHES AT A HIP.

27. ALL MATERIAL, HARDWARE, APPLIANCES, CABINETS, INTERIOR FINISHES, COLOR ETC. SHALL BE APPROVED BY OWNER AND/OR BUILDER PRIOR TO INSTALLATION.

1080 Farnsworth Rd. Waterville, OH 43566 419450.0636 tel ajchristy007@hotmail.com



Designing Remodeling

PROJECT TITLE:

New Residence for Steve & Lisa


GENERAL CONTRACTOR:



STONE DETAIL AT FOUNDATION

REAR ELEVATION

1/4" = 1'-0"

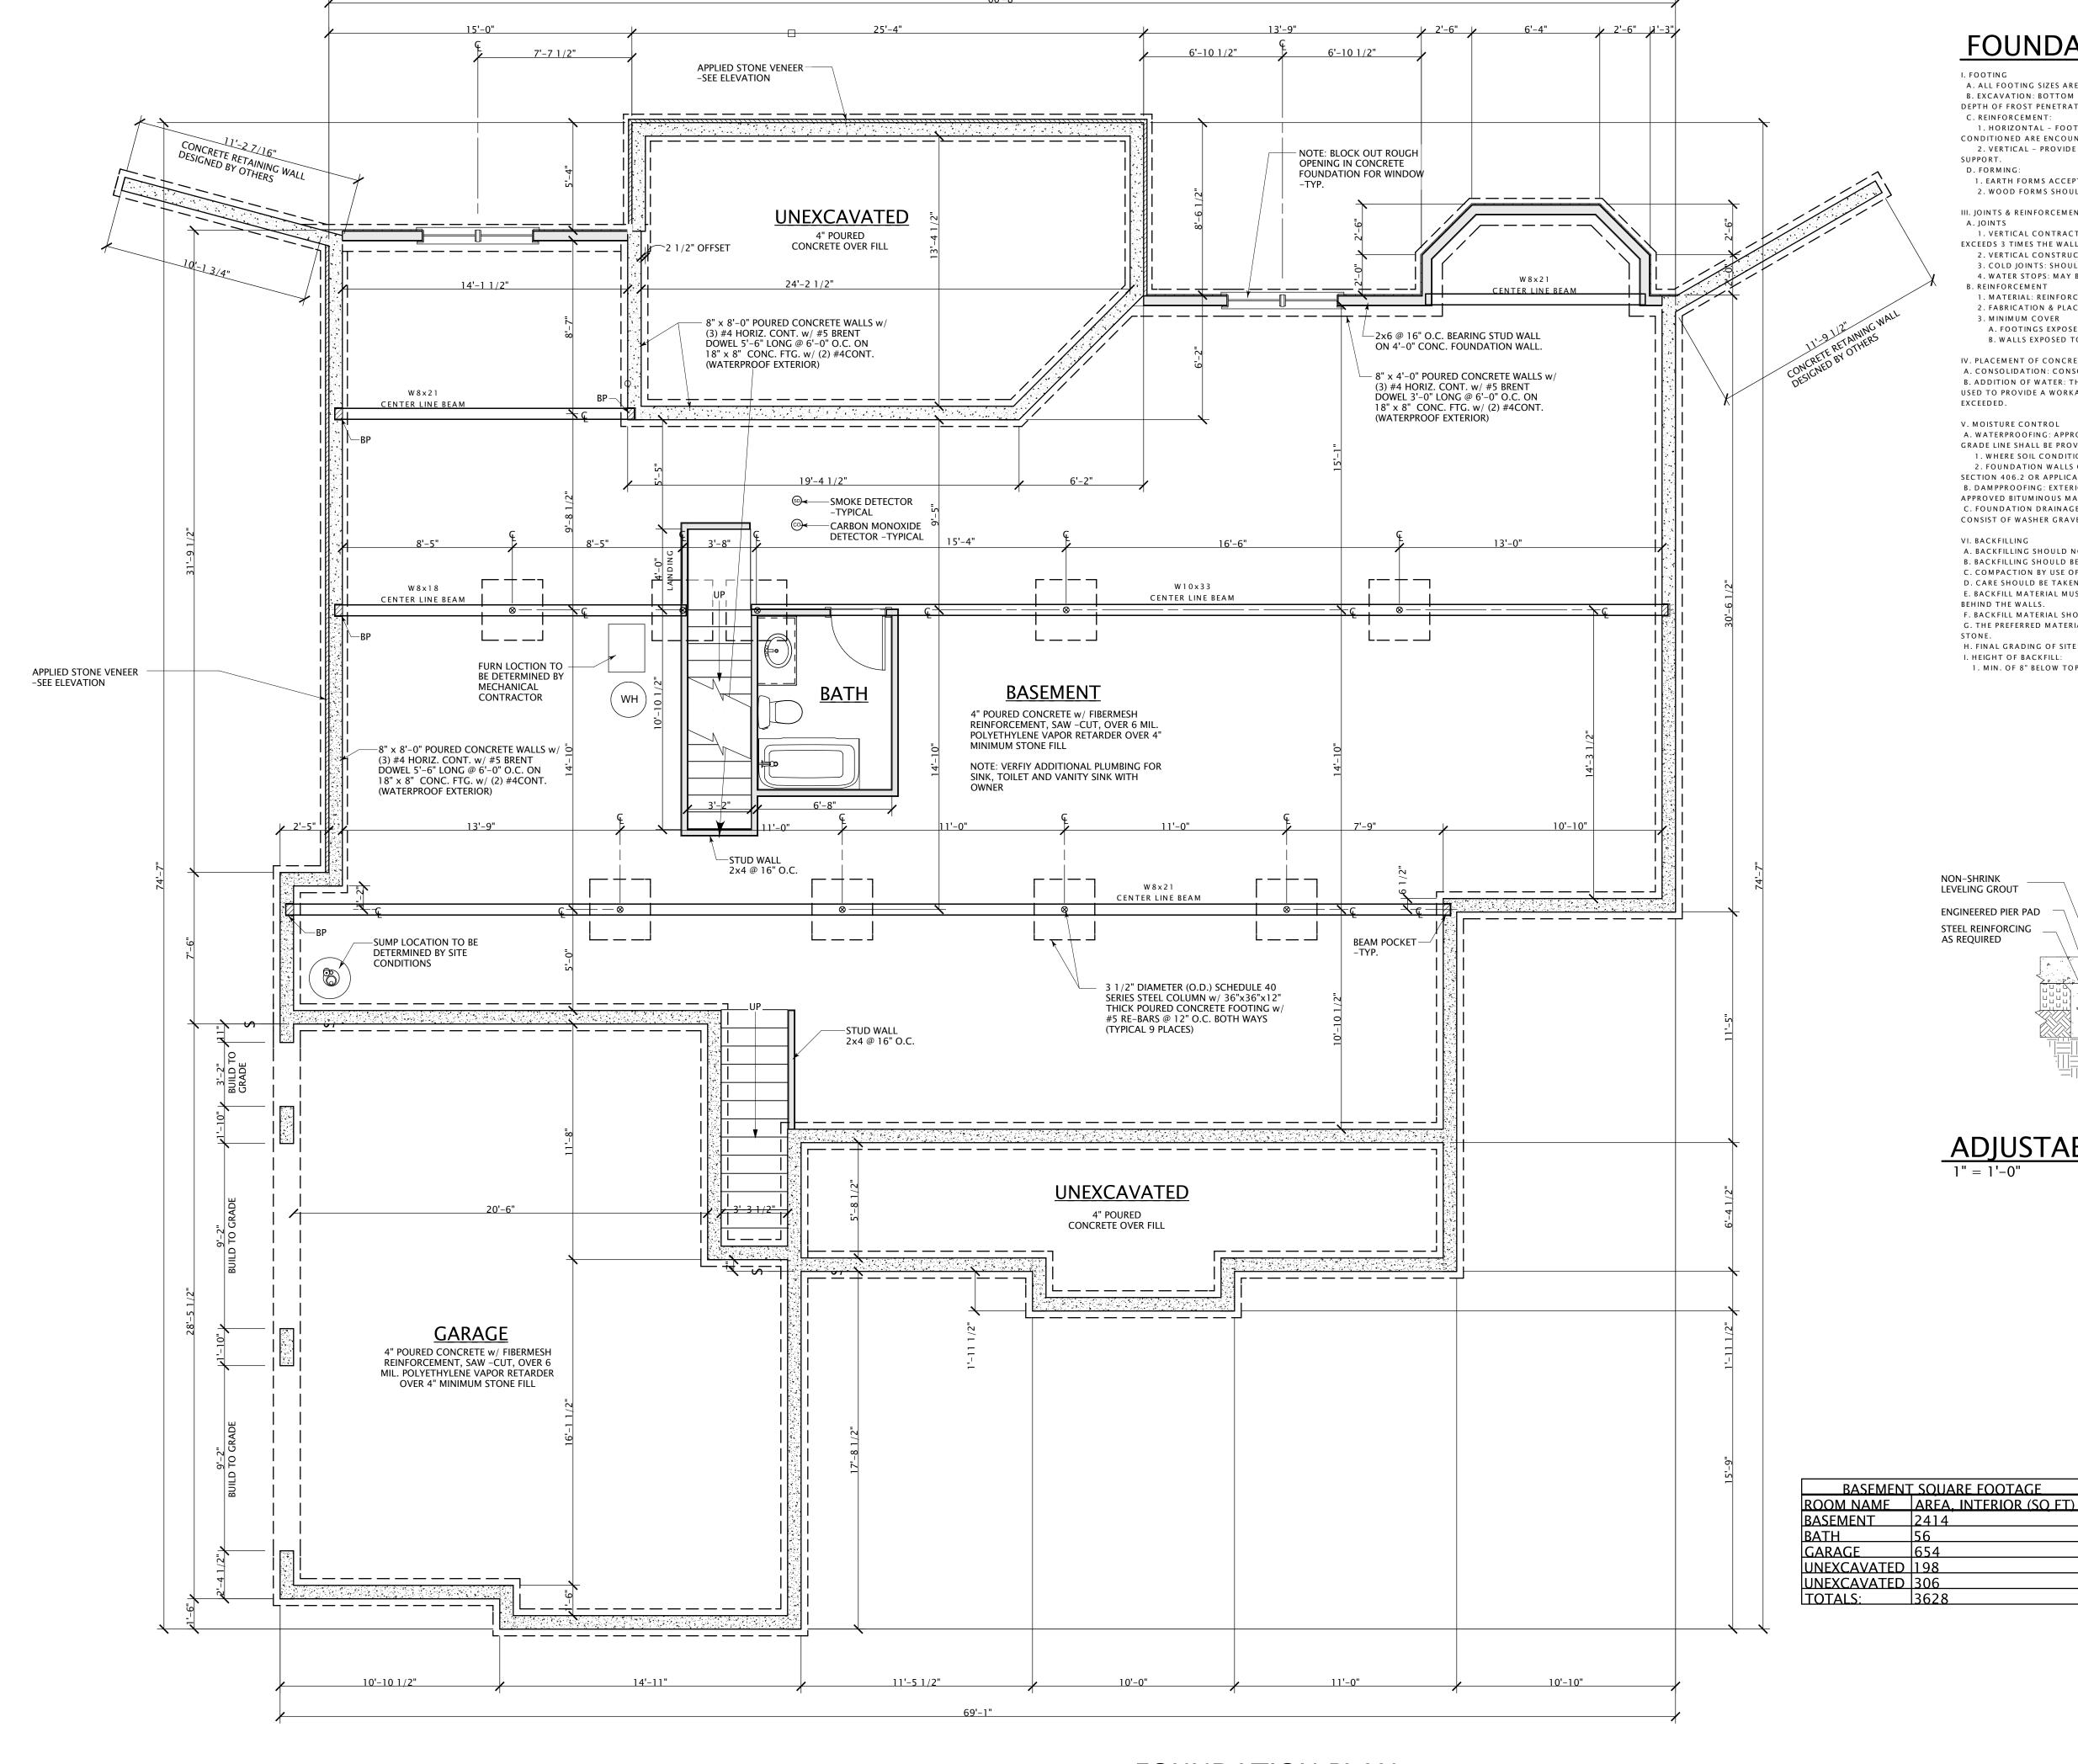

FOUNDATION PLAN

FOUNDATION NOTES:

A. ALL FOOTING SIZES ARE BASED ON AN ASSUMED SOIL BEARING CAPACITY OF 2000 POUNDS PER SQUARE FEET. B. EXCAVATION: BOTTOM OF FOOTING SHALL EXCAVATED TO DEPTH OF 2" BELOW UNDISTURBED SOIL AND 6" BELOW THE DEPTH OF FROST PENETRATION. C. REINFORCEMENT:

1. HORIZONTAL – FOOTINGS SHOULD CONTINUOUS HORIZONTAL REINFORCEMENT WHEN UNSTABLE OR SOIL CONDITIONED ARE ENCOUNTERED (ALLOWABLE SOIL PRESSURE BELOW 2000 P.S.F.) 2. VERTICAL - PROVIDE VERTICAL DOWELS AS SHOWN ON DRAWINGS. DOWELS TO BE TIED TO KEYWAY STRIP FOR

SUPPORT. D. FORMING:

2. WOOD FORMS SHOULD BE USED WHEN NON-COHESIVE SUCH AS SAND ARE ENCOUNTERED.

1. EARTH FORMS ACCEPTABLE WHEN COHESIVE SOILS SUCH AS CLAY ARE ENCOUNTED.

III. JOINTS & REINFORCEMENT A. JOINTS

1. VERTICAL CONTRACTION JOINTS: TO BE PROVIDED WHEN THE STRAIGHT LENGTH OF WALL (BETWEEN CORNERS) EXCEEDS 3 TIMES THE WALL HEIGHT. HORIZONTAL WALL REINFORCEMENT SHOULD CONTINUE ACROSS THE JOINTS. 2. VERTICAL CONSTRUCTION IOINTS: REQUIRED WHERE ONE DAY'S PLACEMENT ENDS.

- 3. COLD JOINTS: SHOULD BE PREVENTED WITH TIMELY DELIVERIES OF CONCRETE AND/OR WITH A VIBRATOR. 4. WATER STOPS: MAY BE REQUIRED WHERE GROUND WATER CONDITIONS DICTATE. B. REINFORCEMENT
- 1. MATERIAL: REINFORCEMENT STEEL SHALL CONFORM TO A.S.T.M. A615 GRADE 60 2. FABRICATION & PLACEMENT: CONFORM TO CRSI "SPECIFICATIONS FOR PLACING OF REINFORCEMENT"
- 3. MINIMUM COVER C. WALLS INTERIOR FACE-3/4" A. FOOTINGS EXPOSED TO EARTH- 3"

B. WALLS EXPOSED TO EARTH- 1 1/2" (#5 BARS OR SMALLER)

A. CONSOLIDATION: CONSOLIDATION OF CONCRETE SHALL BE ACHIEVED WITH THE USE OF INTERNAL VIBRATORS. B. ADDITION OF WATER: THE ADDITION OF WATER AT THE JOB SITE IS PERMITTED PROVIDING ONLY SUFFICIENT WATER IS USED TO PROVIDE A WORKABLE MIX AND THE DESIGN WATER CEMENT RATIO AND/OR THE MAXIMUM SLUMP ARE NOT EXCEEDED.

GRADE LINE SHALL BE PROVIDED AS FOLLOW:

V. MOISTURE CONTROL A. WATERPROOFING: APPROVED WATERPROOFING RETARDER CONTINUOUS FROM THE EDGE OF FOOTING TO THE FINISH

1. WHERE SOIL CONDITIONS INDICATE THAT THE WALLS COULD BE SUBJECT TO WATER PRESSURE. 2. FOUNDATION WALLS OF HABITABLE ROOMS LOCATED BELOW GRADE SHALL BE WATERPROOFED AS PER O.B.O.A.-SECTION 406.2 OR APPLICABLE LOCAL BUILDING CODE. B. DAMPPROOFING: EXTERIOR FOUNDATION WALLS ENCLOSING BASEMENTS SHALL BE DAMPPROOFED BY APPLYING AN

APPROVED BITUMINOUS MATERIAL TO THE WALL FROM THE FOOTING TO THE FINISHED GRADE. C. FOUNDATION DRAINAGE: PROVIDE PERFORATED PVC PIPE AT OR BELOW THE BASEMENT FLOOR. BEDDING OR FILL TO CONSIST OF WASHER GRAVEL OR CRUSHED ROCK. MINIMUM BEDDING REQUIRED: 2", MINIMUM COVER REQUIRED 6"

VI. BACKFILLING A. BACKFILLING SHOULD NOT BE DONE UNTIL FIRST FLOOR FRAMING IS IN PLACE OR SHORING OF THE WALL IS PROVIDED.

- B. BACKFILLING SHOULD BE PLACED IN LIFTS FROM 8" TO 15" IN DETH. C. COMPACTION BY USE OF FLOODING OR ANY OTHER KIND OF WATER INFILTRATION WILL NOT BE PERMITTED. D. CARE SHOULD BE TAKEN TO PREVENT DAMAGE TO WATERPROOFING AND DRAINAGE SYSTEMS.
- E. BACKFILL MATERIAL MUST HAVE SUFFICIENT INHERENT PERMEABILITY TO INSURE ADEQUATE DRAINAGE OF RAIN WATER BEHIND THE WALLS.
- F. BACKFILL MATERIAL SHOULD NOT BE PLACED ON FROZEN GROUND NOR SHOULD IT CONTAIN ANY FROZEN MATERIAL. G. THE PREFERRED MATERIAL FOR USE AS BACKFILL WILL BE GRANULAR SOILS SUCH AS SAND, GRAVEL AND CRUSHED
- H. FINAL GRADING OF SITE SHOULD SLOPE AWAY FROM BUILDING AT NO LESS THAN ONE QUARTER OF AN INCH PER FOOT.
- I. HEIGHT OF BACKFILL: 1. MIN. OF 8" BELOW TOP OF FOUNDATION WALL 2. MIN. OF 4" BELOW TOP OF FOUNDATION WALL WITH BRICK VENEER.

1080 Farnsworth Rd. Waterville, OH 43566 419450.0636 tel ajchristy007@hotmail.com




Designing Planning Remodeling

PROJECT TITLE:

New Residence for Steve & Lisa Potter

GENERAL CONTRACTOR:

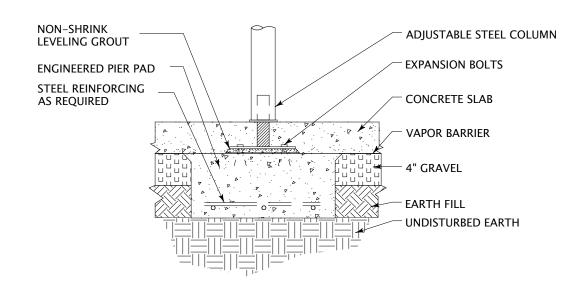

ADJUSTABLE COLUMN DETAIL 1" = 1'-0"

BASEMENT SOUARE FOOTAGE

3628

GARAGE


REVISION:

FOR PRICING AND PERTIMS 03.04.16

DESIGNER: AJC APPROVED:

AD JOB NO. 0202-15

SHEET NO.

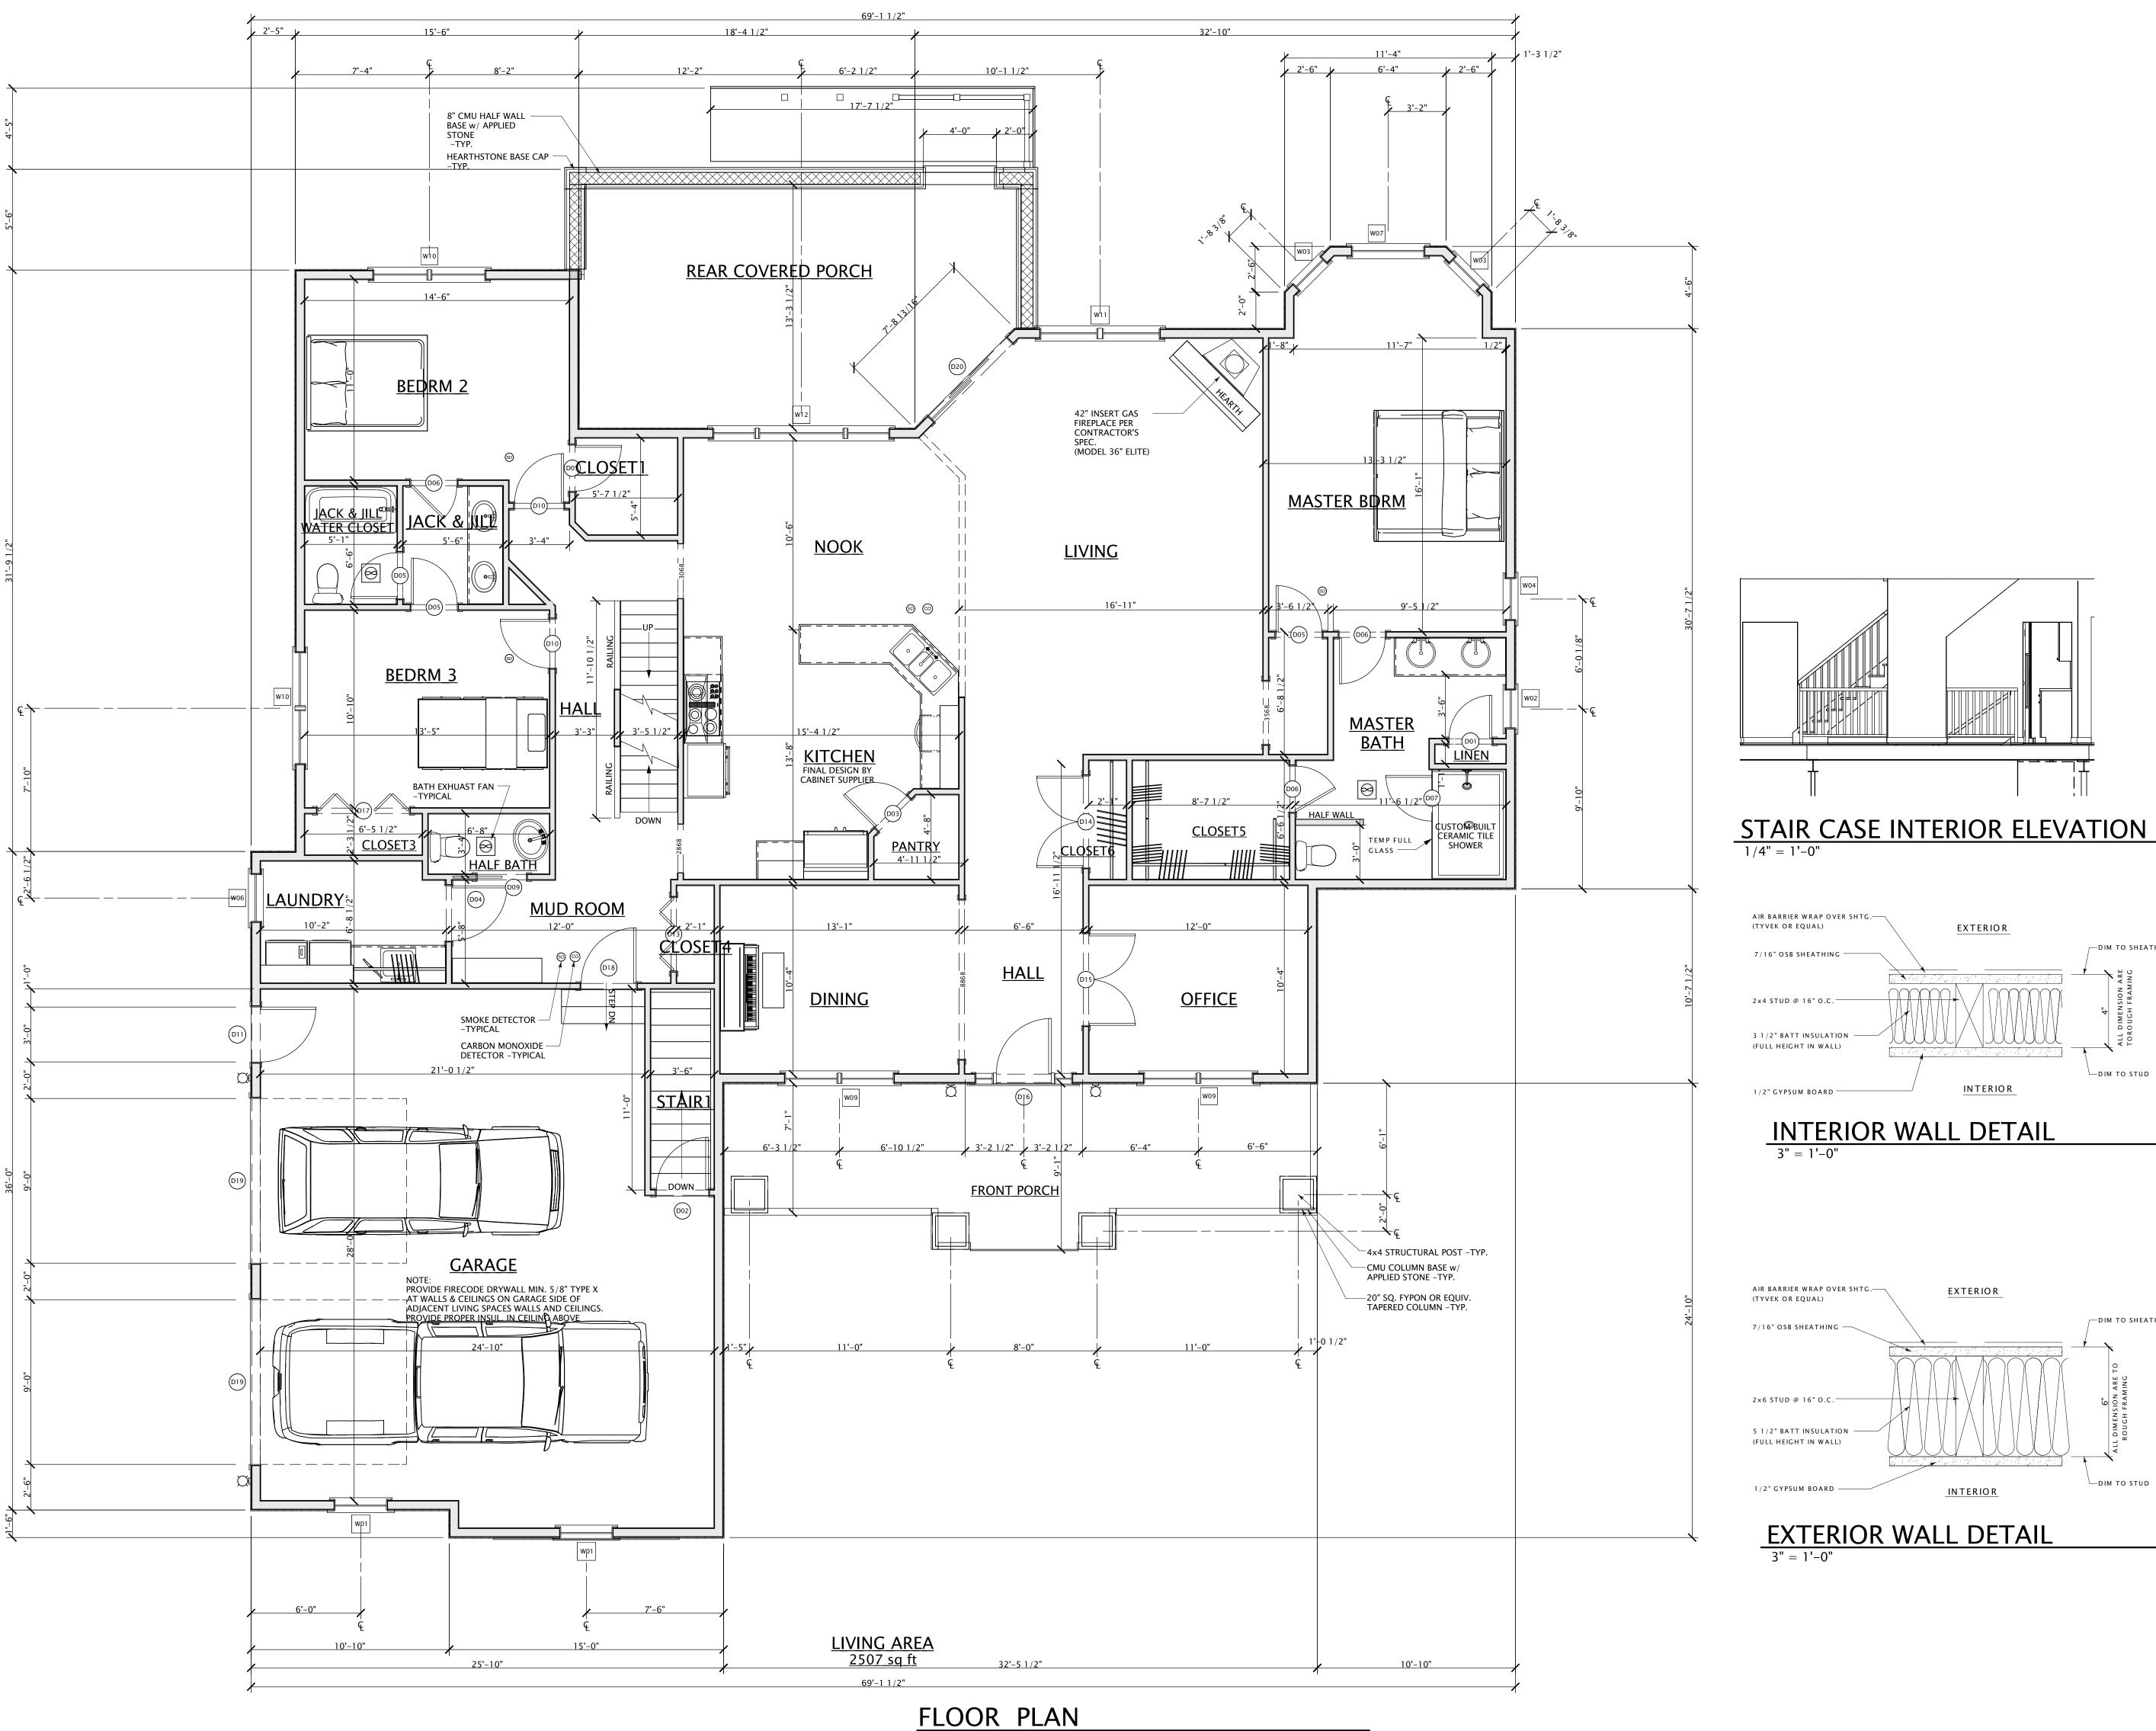

1080 Farnsworth Rd. Waterville, OH 43566 419450.0636 tel ajchristy007@hotmail.com




Designing Planning Remodeling


PROJECT TITLE:

New Residence for Steve & Lisa Potter

GENERAL CONTRACTOR:

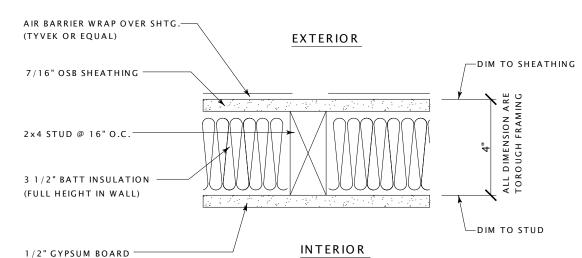

INTERIOR WALL DETAIL 3" = 1'-0"

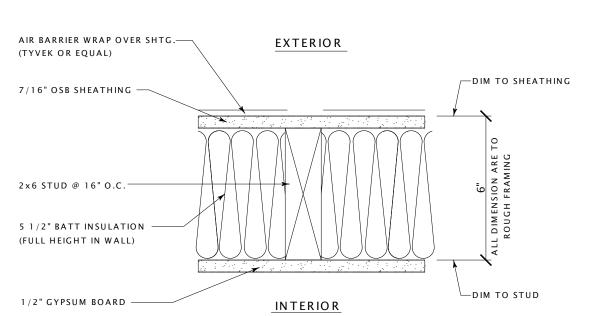

EXTERIOR WALL DETAIL

SHEET NO.

REVISION:


DESIGNER: AJC

AD JOB NO. 0202-15

APPROVED:

03.04.16 FOR PRICING AND PERTIMS

A5.0

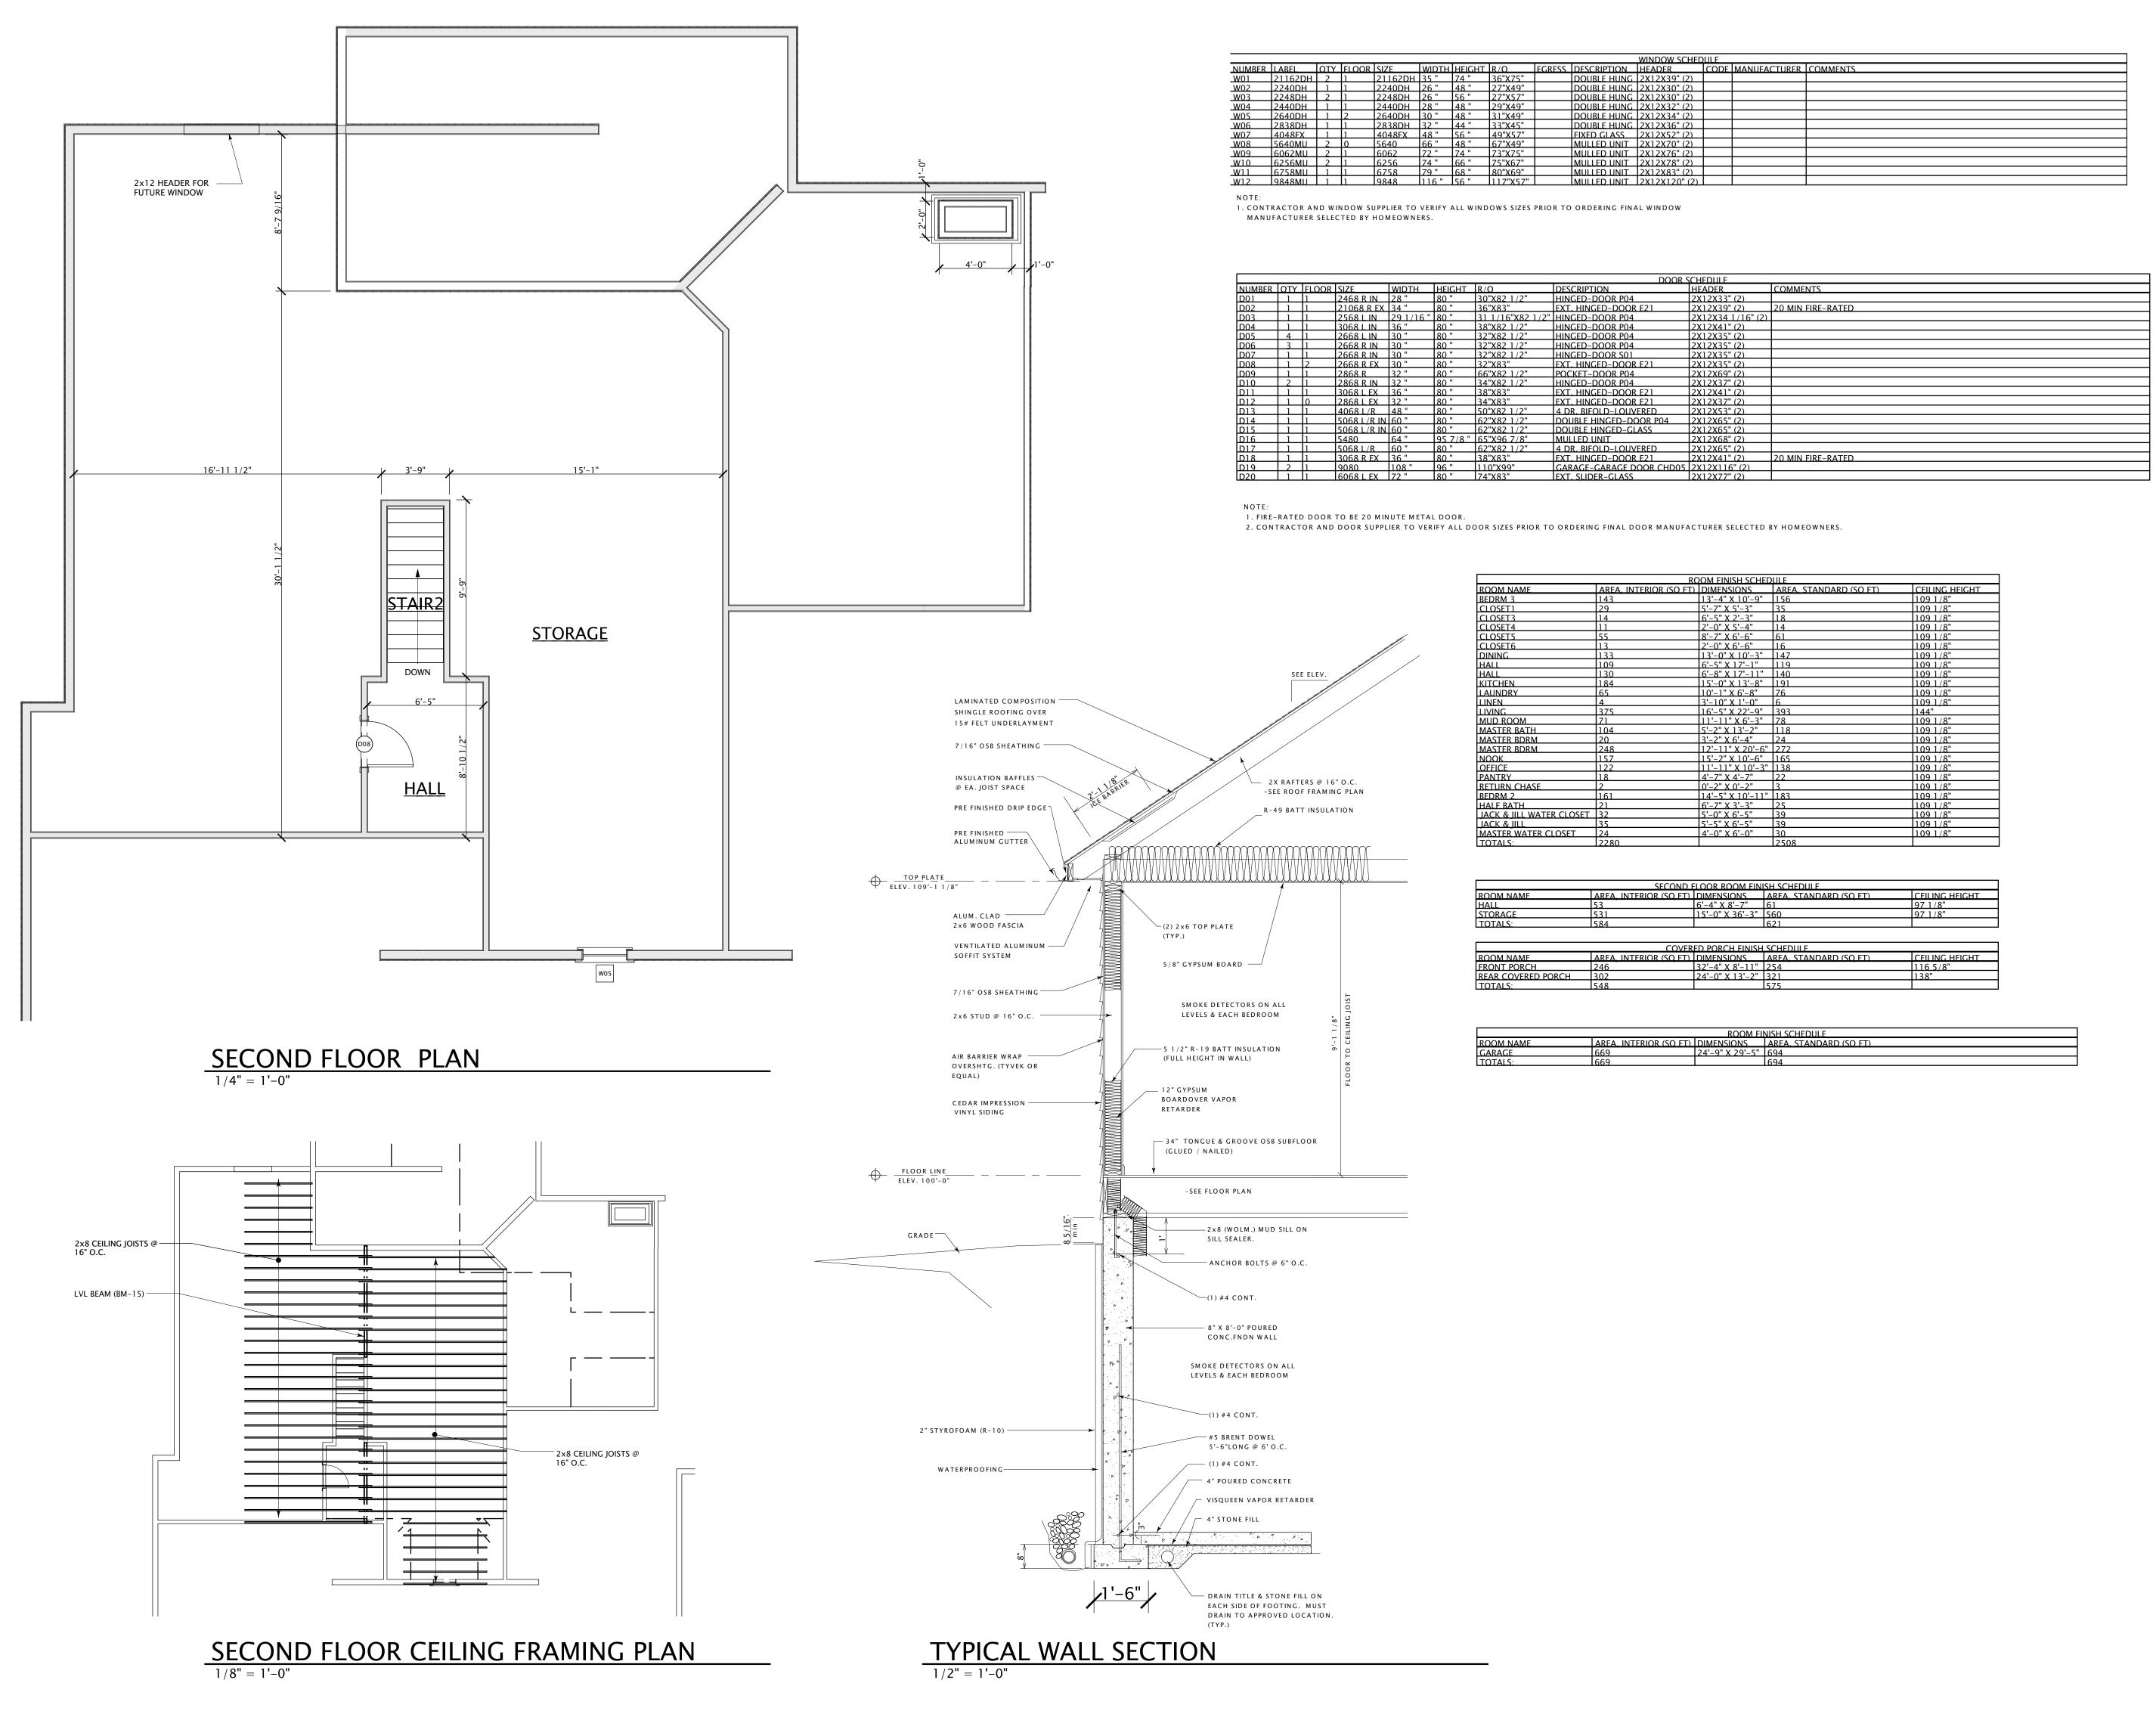

1080 Farnsworth Rd. Waterville, OH 43566 419450.0636 tel ajchristy007@hotmail.com



Designing Planning Remodeling

PROJECT TITLE:

New Residence for Steve & Lisa Potter

GENERAL CONTRACTOR:

REVISION:

.04.16 FOR PRICING AND PERTIMS


DESIGNER: AJC


APPROVED:

AD JOB NO. 0202-15

SHEET NO.

A6.0

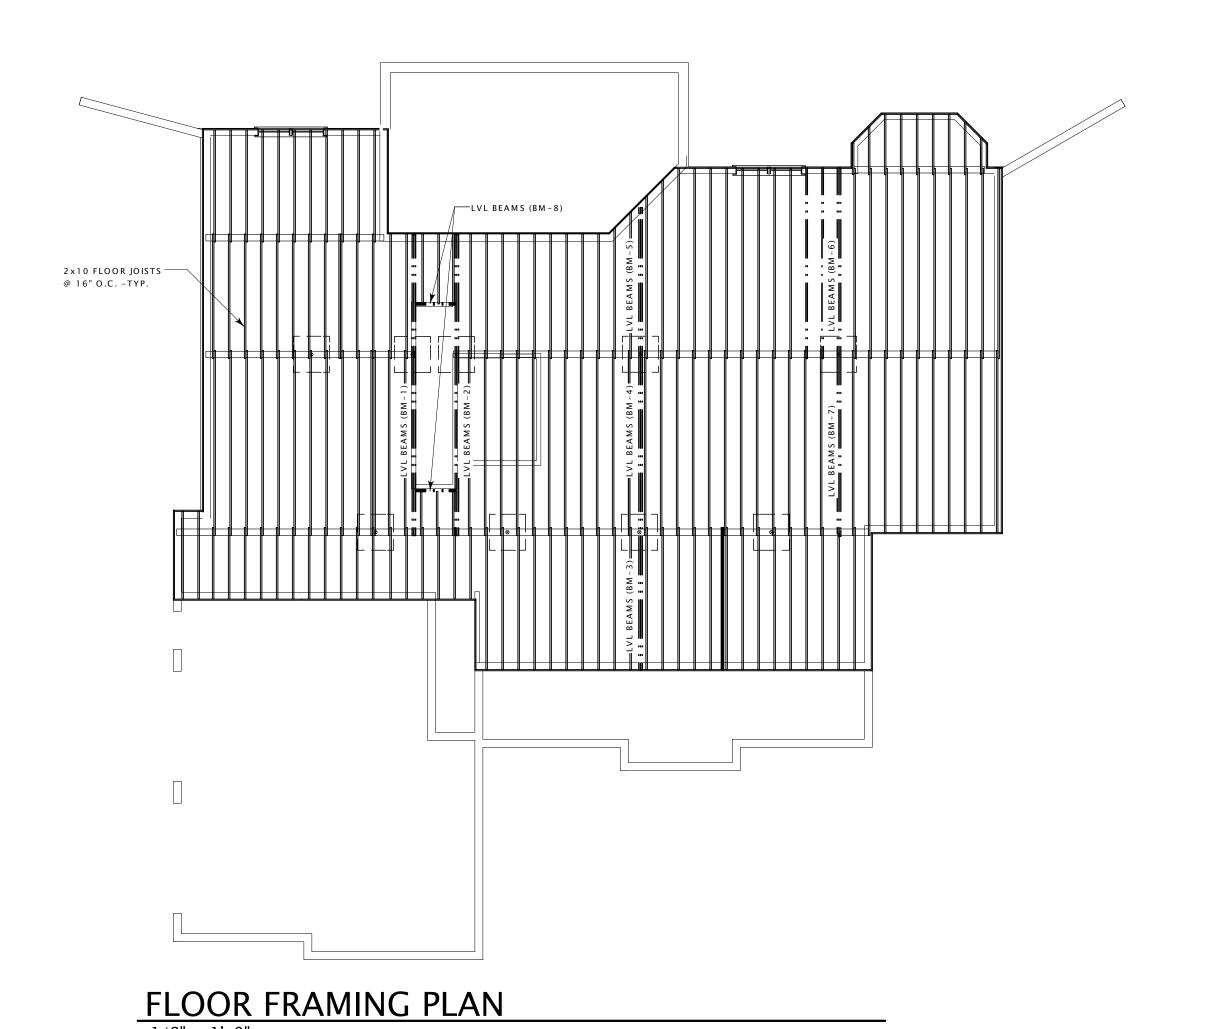

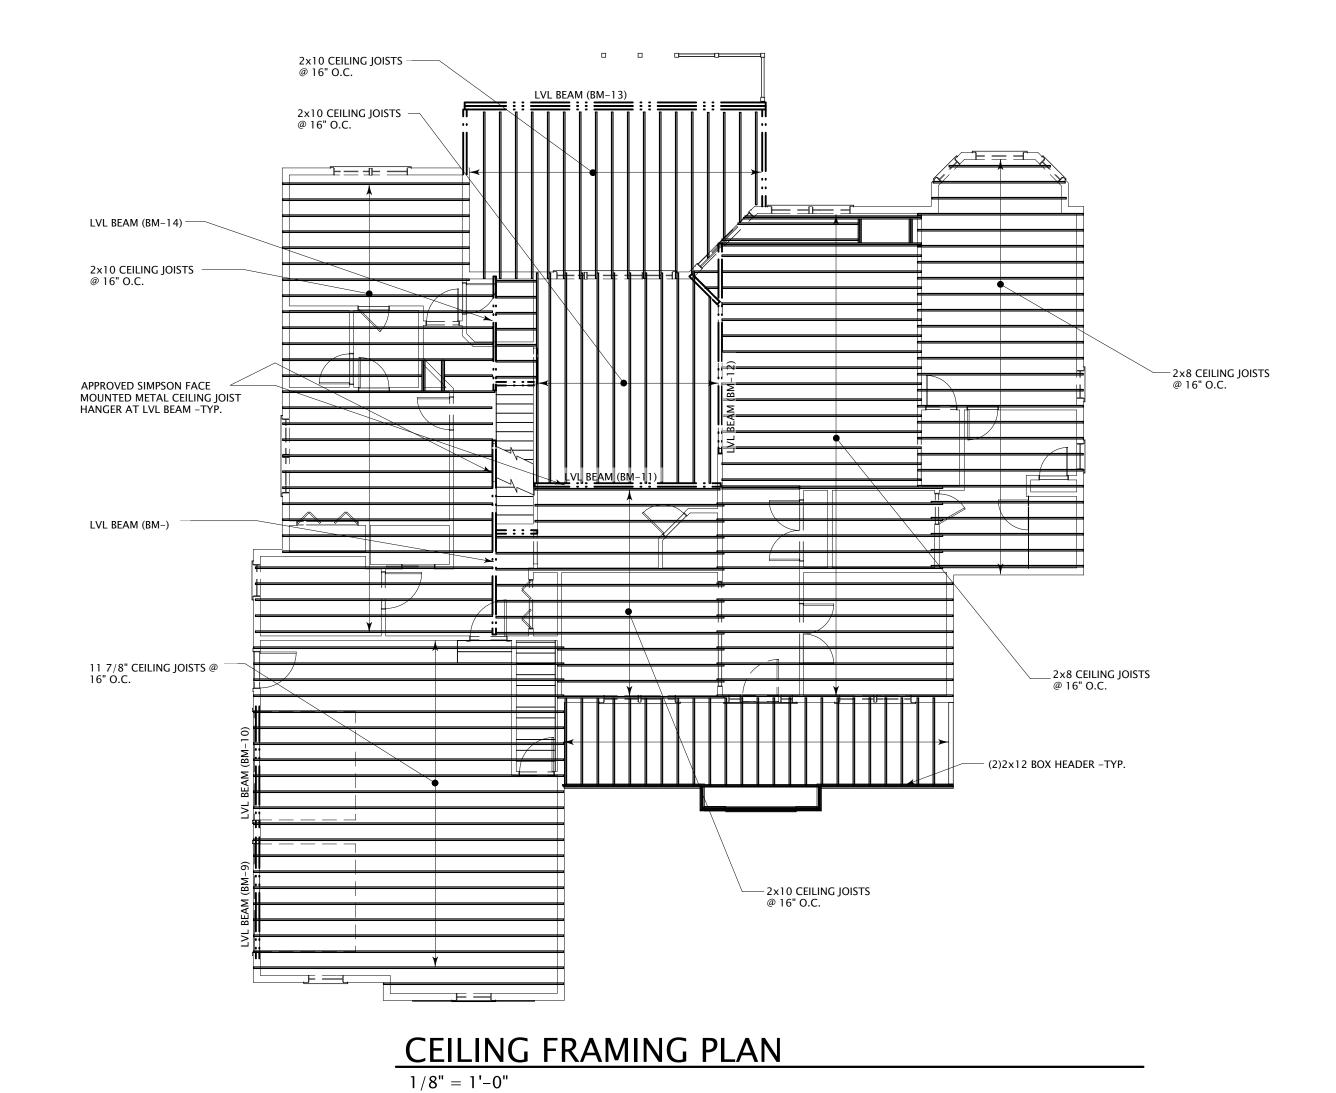

419450.0636 tel ajchristy007@hotmail.com ArcH DESIGN Designing Planning Remodeling

1080 Farnsworth Rd. Waterville, OH 43566

PROJECT TITLE:

New Residence for Steve & Lisa Potter

GENERAL CONTRACTOR:

STRUCTURAL NOTES:

1. LIVE LOADS, DEAD LOADS, WIND LOADS, SNOW LOADS, LATERAL LOADS, SEISMIC ZONING AND ANY SPECIALTY LOADING CONDITIONS WILL NEED TO BE CONFIRMED PRIOR TO CONSTRUCTION AND ADJUSTMENT TO PLANS MADE ACCORDINGLY. SEE YOUR <u>LOCAL BUILDING OFFICIALS</u> FOR VERIFICATION OF YOUR SPECIFIC LOAD DATA, ZONING RESTRICTIONS AND SITE

2. ANY FRAMING OR STRUCTURAL MEMBER THAT ARE NOT INDICATED OR SHOWN ON PLAN ARE TO BE SPECIFIED OR SIZED BY OTHERS.

3. ALL CONCRETE, WOOD, STEEL AND ETC. STRUCTURAL MEMBERS SHALL BE A GOOD GRADE & QUALITY & MEET ALL NATIONAL, STATE AND LOCAL BUILDING CODES WHERE APPLICABLE.

4. ALL WOOD LAMINATED BEAMS (L.V.L. BEAMS ETC.) ARE TO BE SIZED BY OTHERS IF NOT INDICATED. IF A WOOD BEAM SCHEDULE HAS BEEN PROVIDED AND BEAM SIZES APPEAR IN THAT SCHEDULE, THOSE SIZE WERE PROVEN BY OTHERS. IN NO CASE WHATSOEVER DOES AARON J CHRISTY ACCEPT ANY LIABILITY FOR ANY BEAM SIZES SPEARING ON THESE

5. CONTRACTOR TO CONFIRM THE SIZE, SPACING AND SPECIES OF ALL FRAMING & STRUCTURAL MEMBER TO MEET ALL APPLICABLE LOCAL CODES.

- 6. SUBSTITUTION FOR STRUCTURAL MEMBER SHOULD BE MADE ONLY AFTER CONSULTING A QUALIFIED ENGINEER.
- 7. ALL COLUMNS OR SOLID MEMBER SHOULD EXTEND DOWN THROUGH THE LEVELS BELOW AND TERMINATE AT THE BASEMENT FLOOR OR AT THE OTHER BEARING POINTS DEIGNED TO CARRY THE LOADS.
- 8. ALL LOAD-BEARING HEADERS IN THE EXTERIOR & INTERIOR WALLS OVER DOORS & WINDOWS SHALL BE (2) 2×12'S W/ CONTINUOS 1/2" PLYWOOD UNLESS OTHERWISE NOTED. ALL HEADER TO HAVE MIN. 3" BEARING EACH END FOR HEADERS
- OF 6'-0" OR LESS, 4 1/2" BEARING EACH END FOR HEADERS OVER 6'-0".
- 9. MINIMUM JOIST BEARING SHALL BE 1 1/2".
- 10. ALL 2x8 AND GREATER DIMENSIONAL LUMBER SHALL BE S.P.F. GRADE 2 OR BETTER
- 11. DOUBLE FLOOR JOIST UNDER PARTITION WALLS ARE PARALLEL TO THE JOINT DIRECTION.
- 12. ALL WALLS SHALL HAVE DOUBLE TOP PLATES.
- 13. ANCHOR BOLTS SHALL BE 1/2" DIAMETER, MIN. 7" LONG WITH A 2" LEG, 6'-0" C/C MIN. 12" FORM EVERY CORNER. 14. PROVIDE COLLAR TIES AT UPPER 1/3 OF VERTICAL DISTANCE BETWEEN RIDGE BOARD AND CEILING JOISTS AT 4'-0" C/C
- 15. ALL VALLEY AND HIP RAFTERS OVER 20'-0" SPAN ARE TO BE LAMINATED VENEER LUMBER (L.V.L.)
- 16.2×4 STUD WALLS AT 16" C/C THROUGHOUT UNLESS OTHERWISE NOTED. PAN, TRAY AND CATHEDRAL CEILING ARE PER PLANS OR BUILDER.
- 17. BEAM POCKET TO BE MIN. 4" DEEP FOR BEAM BEARING OR 3 1/2" WITH METAL SHIMS 6" WIDE. 4" CONCRETE OR SOLID BLOCK BACK OF POCKET. MORTAR POCKET SOLID AND MIN. (2) COURSES BLOCK BELOW BEAM.
- 18. PROVIDE APPROVED JOIST HANGERS AT ALL FLUSH BEAMS FOR JOIST CONNECTION.
- 19. ALL ROOF, CEILING AND FLOOR OPENINGS TO BE DOUBLE FRAMED MINIMUM OR AS SHOWN ON THE DRAWINGS. 20. ALL I-JOISTS SHALL HAVE WEB REINFORCING AT BEARING LOCATIONS AND SHALL BE BRACED AND INSTALLED PER
- 21. TONGUE AND GROOVE (T&G) SUBFLOOR TO BE GLUED & NAILED UNLESS OTHERWISE NOTED.
- ALL WOOD TRUSS DESIGNS AND FABRICATIONS MUST BE PRE-ENGINEERED BY TRUSS MANUFACTURER.
- 23. PROVIDE MINIMUM SOLID 2×BLOCKING UNDER FULL POSTS OR BUILT UP POSTS FROM FOUNDATION WALL OR STEEL BEAM TO ORIGIN OF POST LOADING.
- 24. FLOOR JOISTS SHALL BE CROSS-BRIDGED WITH 1x3 BRIDGING AT INTERVALS NOT TO EXCEED 96" AND DOUBLE NAILED AT EACH END.
- 25. STRUCTURAL CALCULATIONS ARE BASED ON THE FOLLOWING LIVE & DEAD LOADS: A) FLOOR JOISTS FIRST FLOOR
- B) FLOOR JOISTS SLEEPING AREAS 40 PSF
- C) ATTIC FLOOR (LIMITED STORAGE) 30 PSF
- D) CEILING JOISTS (NO STORAGE) 15 PSF E) ROOF RAFTERS (SUPPORTING D/W) - 45 PSF
- F) ROOF RAFTERS (NO CEILING LOAD) 35 PSF


STRUCTURAL FRAMING MEMBER SCHEDULE DESIGN VALUES MODULUS OF ELASTICITY $E = 2.0 \times 10^6 \text{psi}$ BENDING STRESS Fb = 3100 psi Fv = 290 psiCOMPRESSION PERPENDICULAR TO GRAIN Fc⊥= 750 psi COMPRESSION PARALLEL TO GRAIN FcII = 3000 psi MEMBER SIZE LOCATION REMARKS MARK BM - 1 BM - 2 BM - 3 BM - 4 BM - 5 BM - 6 BM - 7 BM - 8 BM - 9 BM - 12 BM - 13 BM - 14 ALL WOOD LAMINATED BEAMS (L.V.L. BEAMS, GLUE LAM. BEAMS ECT.) ARE TO BE SIZED BY OTHER. IF BEAM SIZES APPEAR IN THE ABOVE SCHEDULE, THOSE SIZES WERE PROVIDED BY OTHERS; IN NO

CASEWHATSOEVER DOSE THE DESIGNER ACCEPT ANY LIABILITY FOR ANY BEAM SIZES APPEARING ON

THESEPLAN


REVISION	:
03.04.16	FOR PRICING AND I
DESIGNER:	AJC
DESIGNER.	


AD JOB NO. 0202-15

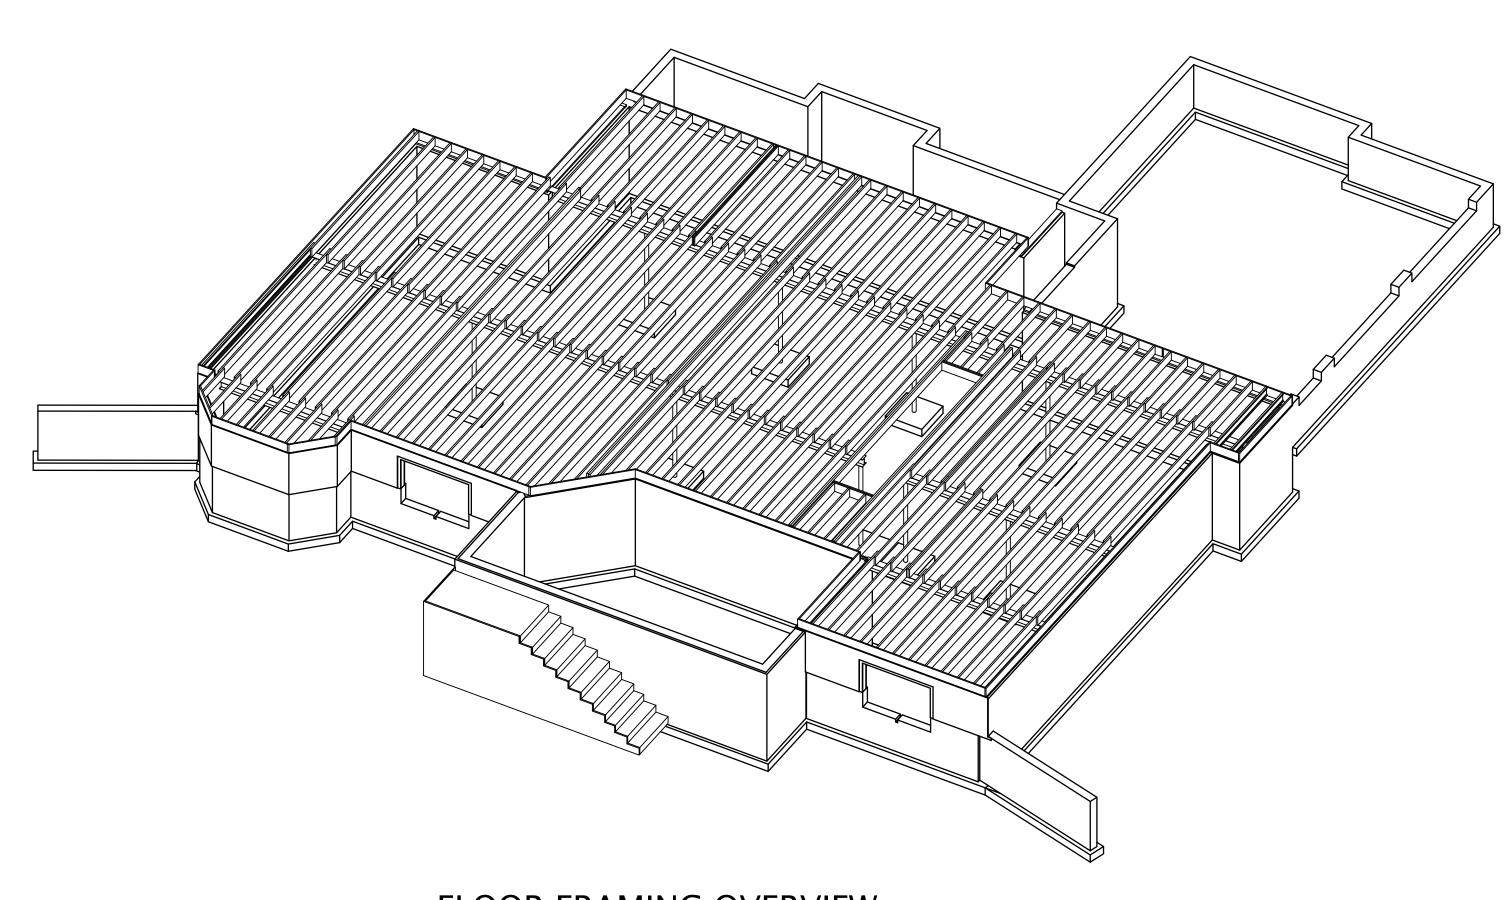


FLOOR FRAMING OVERVIEW

NOTE: RENDING FOR VISUALIZATION PURPOSES ONLY -MAY DIFFER SLIGHTY FROM ACTUAL.

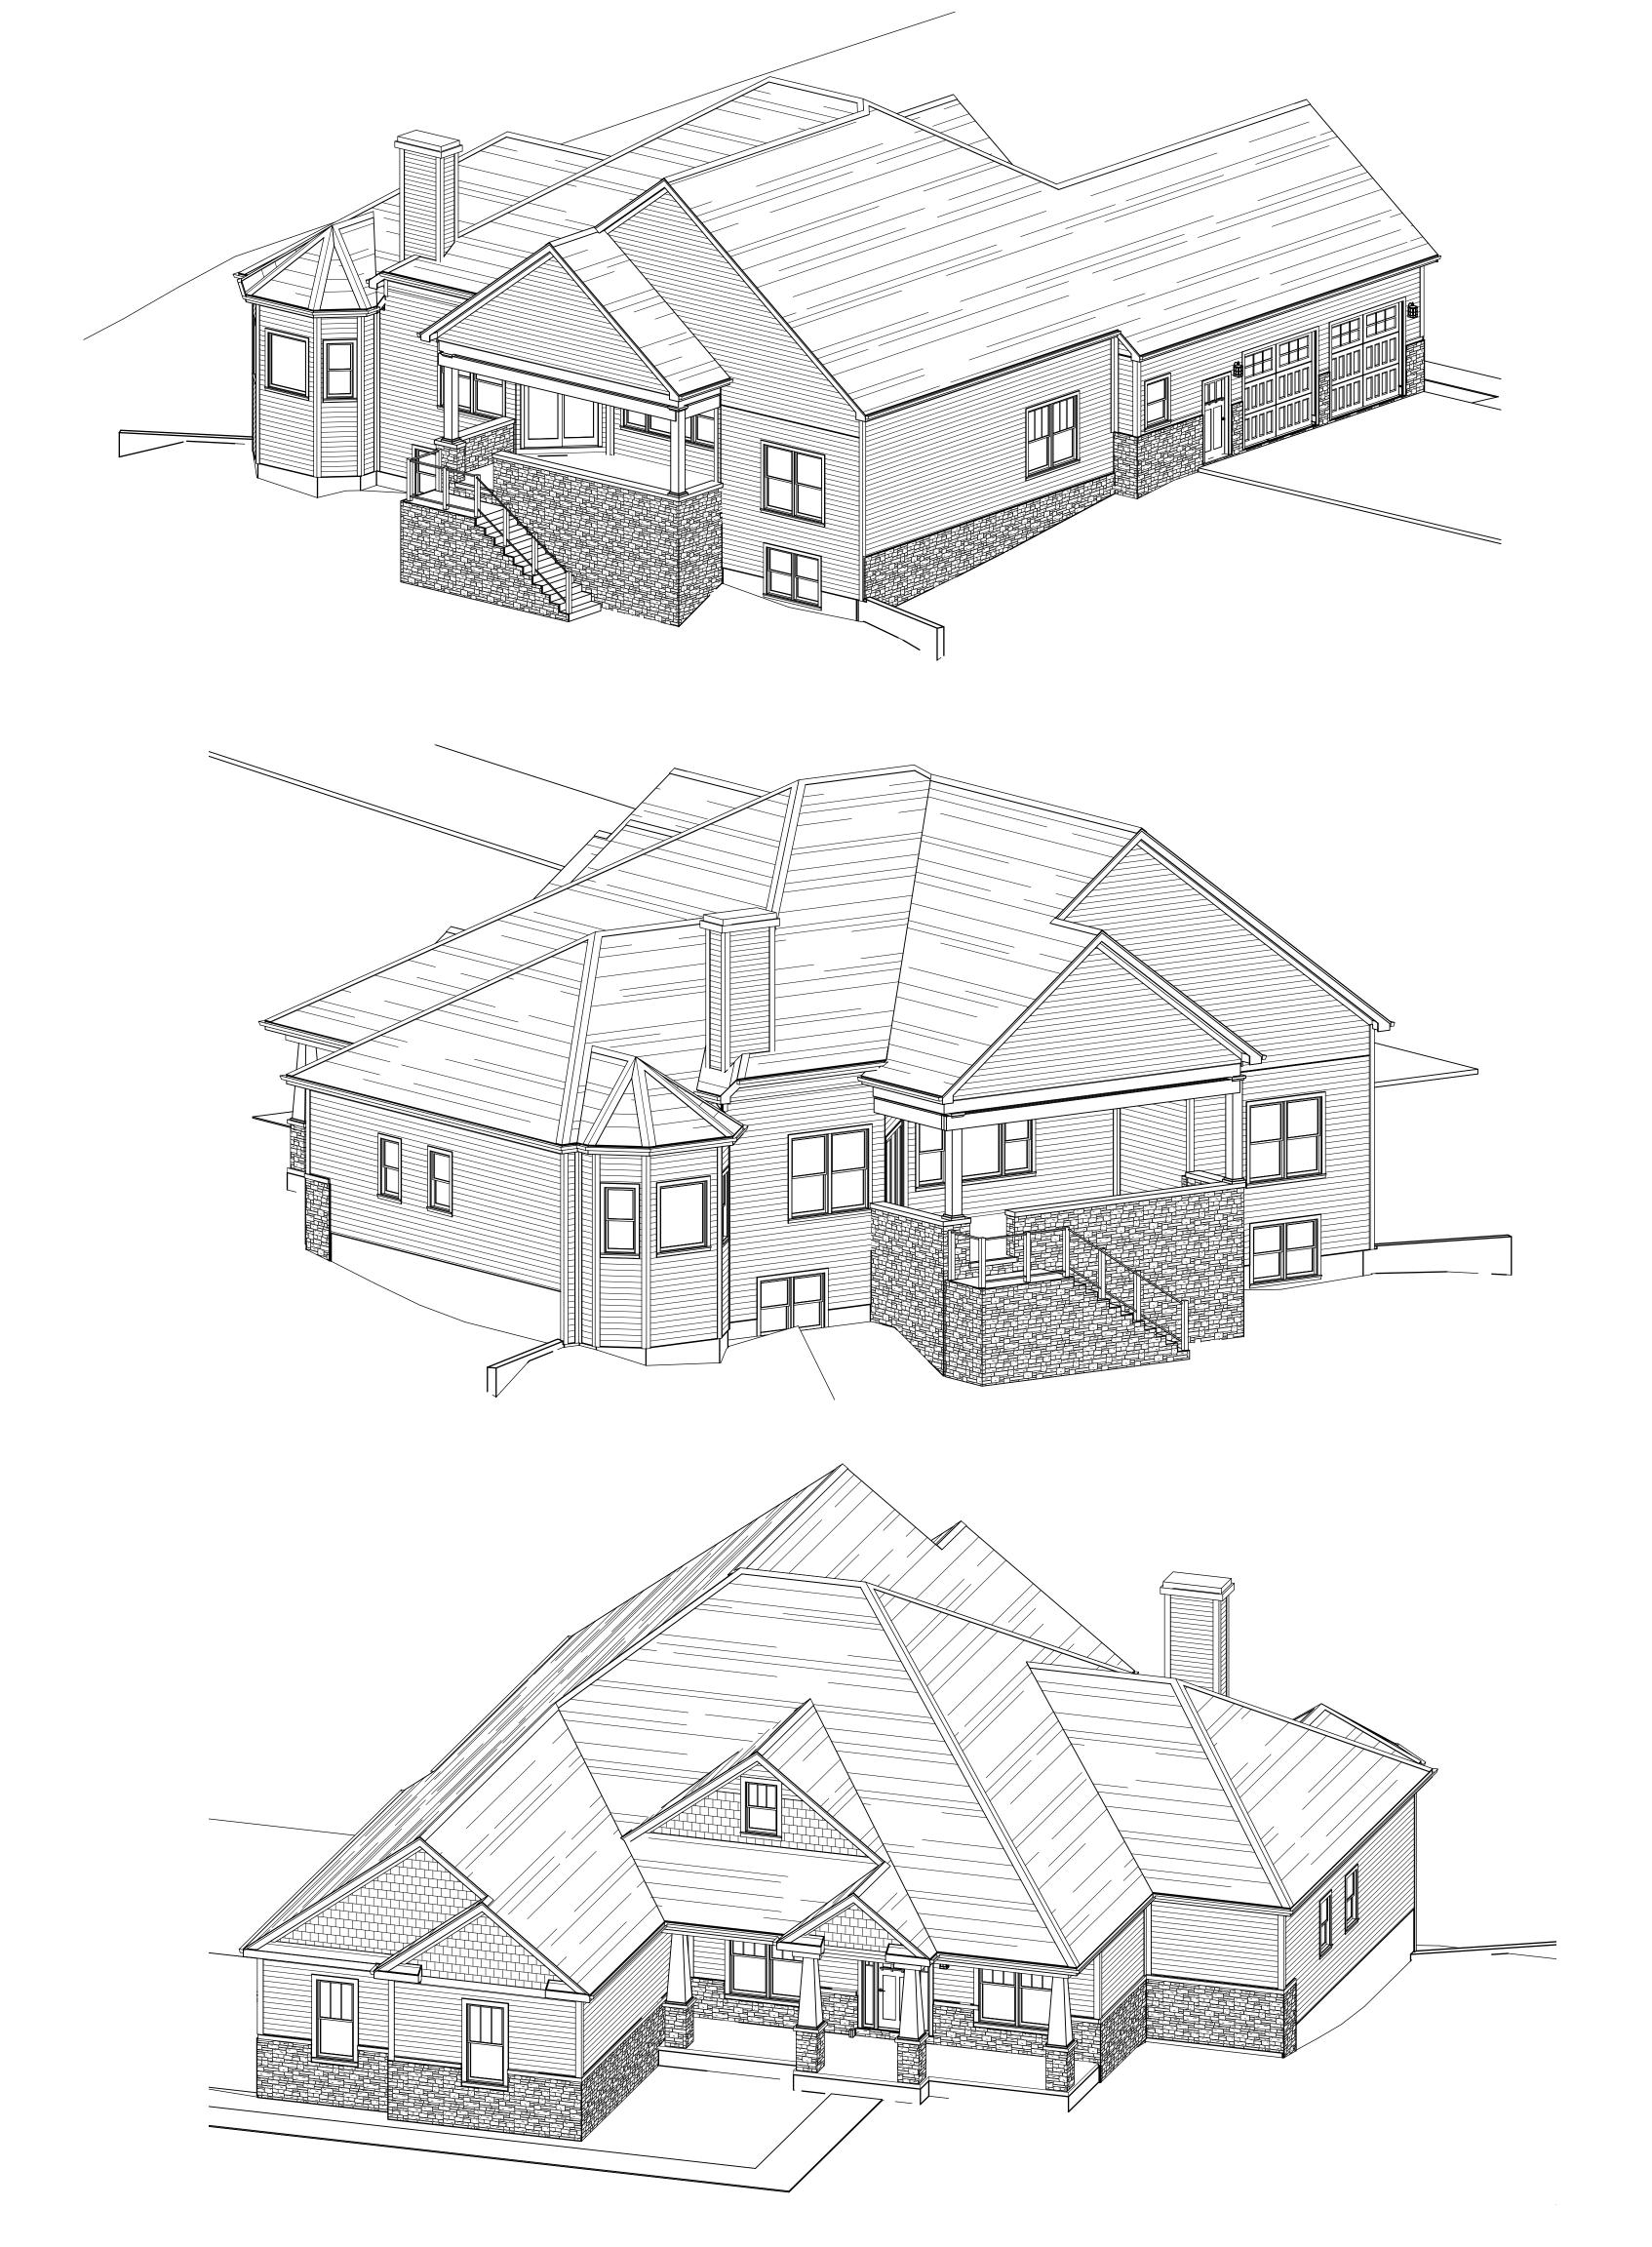

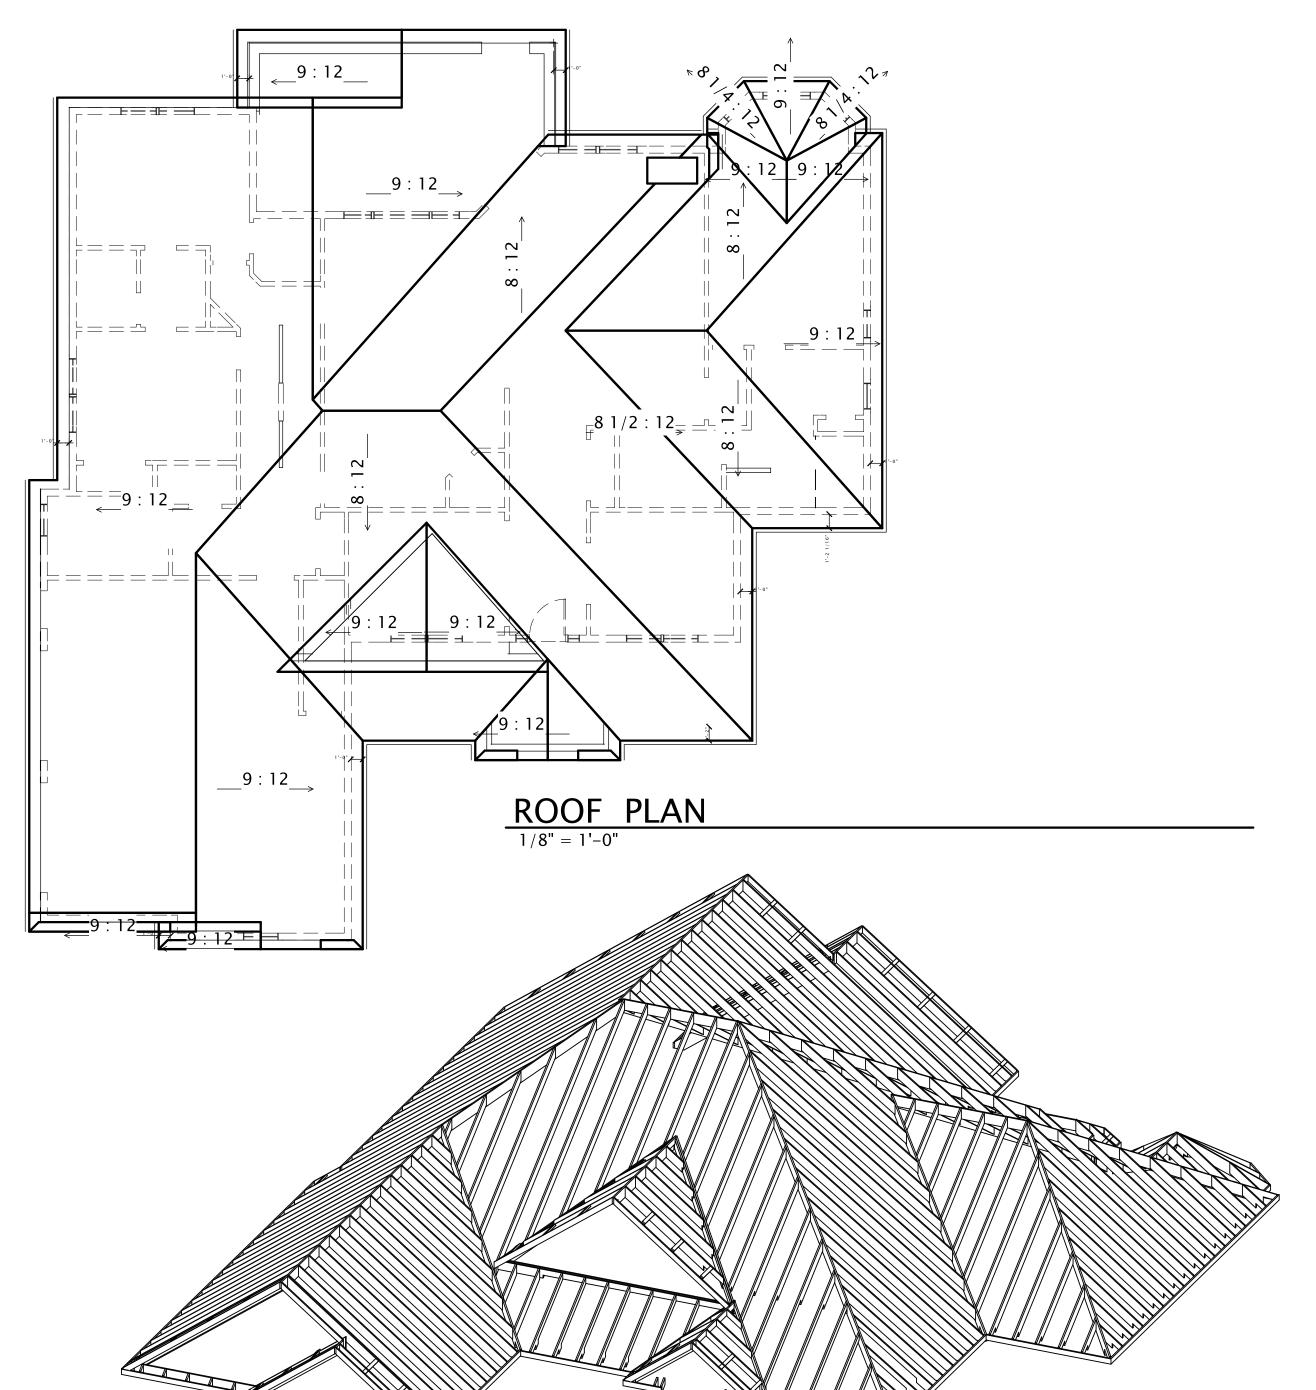

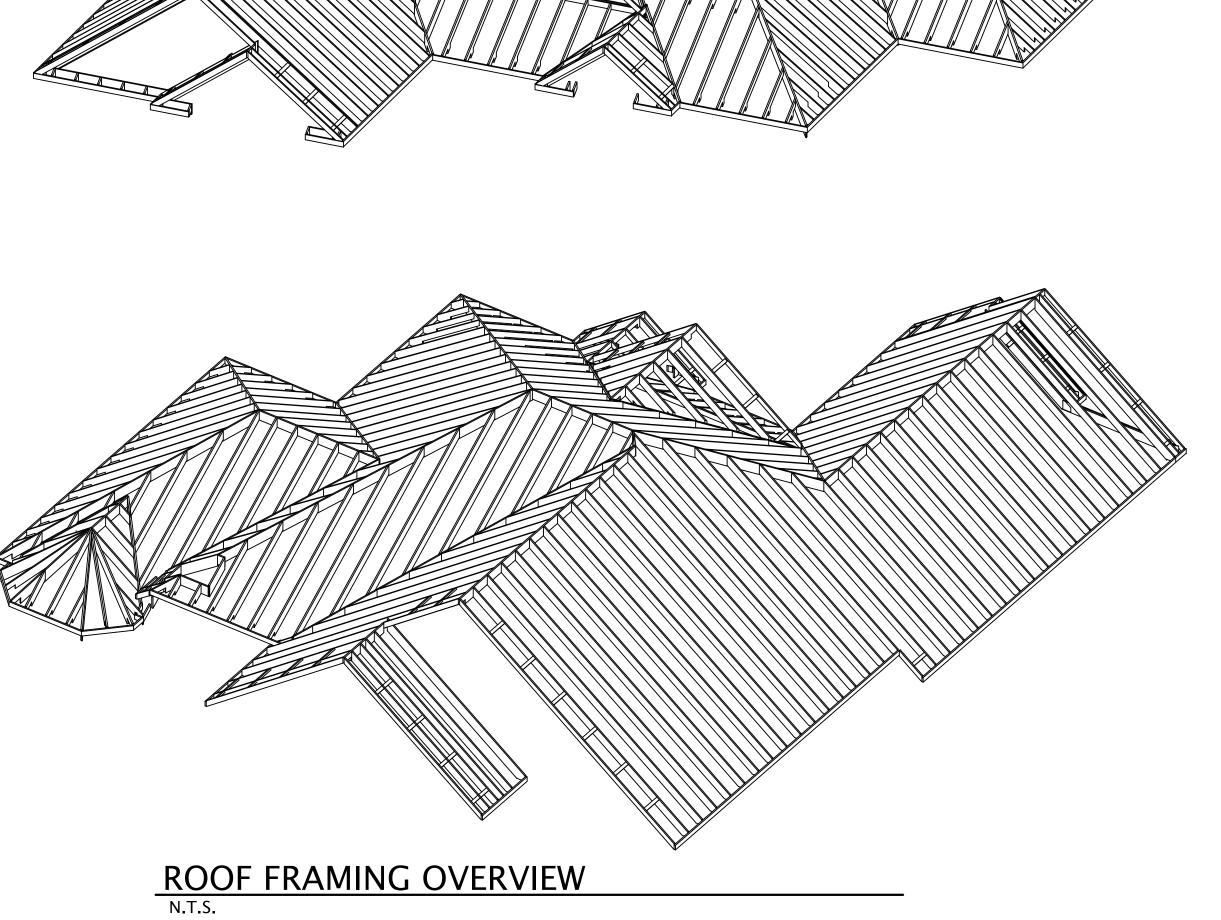

NOTE: RENDING FOR VISUALIZATION PURPOSE ONLY -MAY DIFFER SLIGHTY FROM ACTUAL.

1080 Farnsworth Rd. Waterville, OH 43566 419450.0636 tel ajchristy007@hotmail.com



Designing Planning Remodeling

PROJECT TITLE:

New Residence for Steve & Lisa Potter

GENERAL CONTRACTOR:

REVISION:

FOR PRICING AND PERTIMS

AD JOB NO. 0202-15

SHEET NO.

A8.0